### BID DOCUMENT DRAWINGS

### PLAN REPRODUCTION WARNING

THE PLANS HAVE BEEN CREATED ON ANSI D (22"x34") SHEETS. FOR REDUCTIONS, REFER TO GRAPHIC SCALE.

THE PLANS HAVE BEEN CREATED FOR FULL COLOR PLOTTING. ANY SET OF THE PLANS THAT IS NOT PLOTTED IN FULL COLOR SHALL NOT BE CONSIDERED ADEQUATE FOR CONSTRUCTION PURPOSES.

\*\*WARNING\*\*: INFORMATION MAY BE LOST IN COPYING AND/OR GRAY SCALE PLOTTING.

SHEET INDEX

SITE ASSET AND STRIPING PLAN

COVER SHEET AND MAP

PAVEMENT REPAIR PLAN

GRADING PLAN

ADA CHECK PLAN SIDEWALK RAMP PHASING PLAN



4815 List Drive, Unit 115 Colorado Springs, CO 8091 Phone: 719-632-3593



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SCALE VERIFICATION

ON ORIGINAL DRAWING

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ORIGINAL DRAWING SIZE IS 22 x 34

COVER SHEET AND MAP



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DESIGNED BY	MRS	
DRAWN BY	MRS	
CHECKED BY	JTM	
APPROVED BY	SJMS	

### PROJECT CONTACT

### DESIGN CONSULTANT

KLEINFELDER
CONTACT: JG McCALL
4815 LIST DRIVE, UNIT 115
COLORADO SPRINGS, COLORADO 80919
719-632-3593
JGMcCALL@KLEINFELDER.COM


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VICINITY MAP

THIS PLAN SET IS BASED ON CAD AERIAL PHOTOGRAPHY.

THE CONTRACTOR IS SPECIFICALLY CAUTIONED THAT THE EXISTING UTILITIES INFORMATION SHOWN ON THE THESE PLANS IS NOT TO BE RELIED ON AS BEING EXACT OR COMPLETE. THE CONTRACTOR WILL BE RESPONSIBLE FOR FIELD VERIFYING LOCATIONS AND DEPTHS OF EXISTING UTILITIES BEFORE COMMENCING CONSTRUCTION. THE CONTRACTOR MUST ALSO CALL 811 AT LEAST3 WORKING DAYS BEFORE ANY EXCAVATION TO REQUEST EXACT FIELD LOCATION OF UTILITIES.



### ADA PAVEMENT NOTES

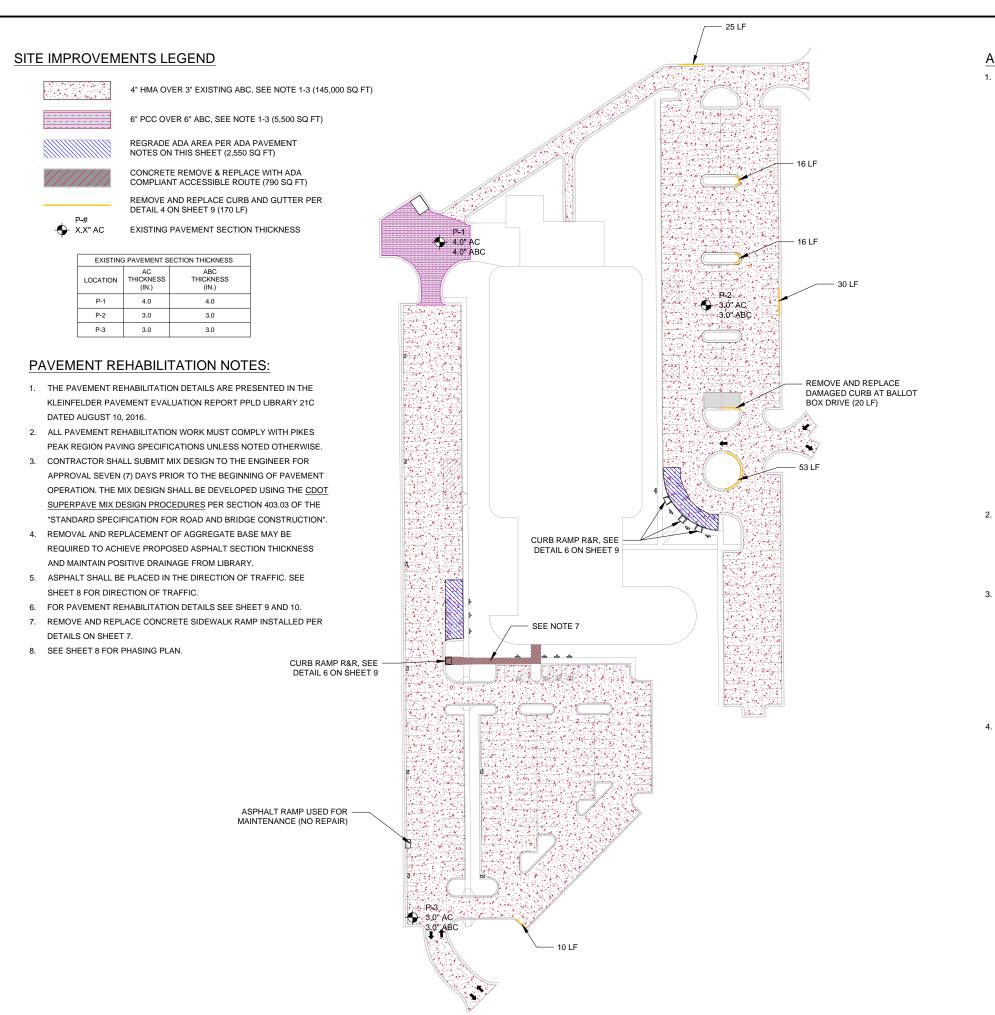- THE CONTRACTOR ASSUMES RESPONSIBILITY THAT ALL ELEMENTS ARE CONSTRUCTED IN ACCORDANCE WITH FEDERAL ADA STANDARDS (2010 ADA).
  - A. ALL ACCESSIBLE ROUTES SHALL BE CONSTRUCTED WITH A RUNNING SLOPE NOT STEEPER THAN 1:20 AND A CROSS SLOPE NOT STEEPER THAN 1:48 (2010 ADA SECTION 403.3).
  - B. ALL CHANGES IN LEVEL ON AN ACCESSIBLE ROUTE GREATER THAN 1/4", OR 1/2" IF BEVELED AT A 1:2 SLOPE, SHALL BE RAMPED, AND SHALL COMPLY WITH 2010 ADA 405 OR 406. (2010 ADA SECTIONS 303.2, 303.3, 303.4).
  - C. ALL DOOR MANEUVERING CLEARANCE AREAS, RAMP LANDINGS, PARKING STALLS, AND ACCESS AISLES SHALL HAVE NO SLOPES EXCEEDING 1:48, AND NO CHANGES IN LEVEL (2010 ADA SECTIONS 404.2.4.4, 405.7.1, 502.4).
  - D. ALL RAMPS SHALL BE CONSTRUCTED WITH A RUNNING SLOPE NOT STEEPER THAN 1:12, AND A CROSS SLOPE NOT STEEPER THAN 1:48 (2010 ADA SECTIONS 405.2, 405.3).
  - E. OTHER THAN CROSS SLOPE AND RUNNING SLOPE, THERE SHALL BE NO CHANGE IN LEVEL ALONG THE ENTIRE RAMP RUN (2010 ADA SECTION 405.4).
  - F. THE RISE FOR ANY RAMP RUN SHALL BE 30 INCHES MAXIMUM (2010 ADA SECTION 405.6).
  - G. ALL RAMPS SHALL BE CONSTRUCTED WITH A LANDING ON THE TOP AND BOTTOM OF EACH RUN (2010 ADA SECTION 405.7)
  - H. RAMP RUNS WITH A RISE GREATER THAN 6 INCHES SHALL HAVE A HANDRAIL INSTALLED (2010 ADA SECTION 405.8).
    THE HANDRAIL SHOULD COMPLY WITH 2010 ADA SECTION
  - I. ON ALL CURB RAMPS THE COUNTER SLOPE SHALL NOT BE GREATER THAN 1:20, AND THE FLARES SHALL NOT BE GREATER THAN 1:10 OR, IN THE CASE OF A RAMP WITH NO LANDING, 1:12 (2010 ADA SECTIONS 406.2, 406.3, 406.4).
  - J. THE BOTTOM OF ALL PARKING SPACE IDENTIFICATION SIGNS SHALL BE A MINIMUM OF 60 INCHES ABOVE THE FINISH FLOOR OR GROUND SURFACE (2010 ADA SECTION 502 6)
- 2. THE PAVEMENT REPAIR AREA WAS ESTIMATED BASED ON DIGITAL LEVEL AND/OR LASER LEVEL DATA. THE CONTRACTOR SHALL VERIFY THAT THE SLOPES AS DESIGNED ARE CONSTRUCTED TO BE COMPLIANT WITH THE 2010 ADA. ACCORDINGLY, THE PAVEMENT REPAIR AREA MAY NEED TO BE ADJUSTED IF DIFFERENT CONDITIONS ARE ENCOUNTERED DURING CONSTRUCTION.
- 3. THE FOLLOWING ARE STANDARD DESIGN SLOPES THAT HAVE BEEN ADOPTED TO ALLOW FOR VARIABILITY IN CONSTRUCTION TOLERANCES:

ELEMENT	CROSS SLOPE	RUNNING SLOPE
CONCRETE ACCESSIBLE ROUTES	1.8%	4.8%
ASPHALT ACCESSIBLE ROUTES	1.5%	4.5%
CONCRETE ACCESSIBLE PARKING	1.8%	1.8%
ASPHALT ACCESSIBLE AREA	1.5%	1.5%
CONCRETE RAMPS	1.8%	7.8%
CONCRETE LANDINGS AND DOORWAYS	1.8%	1.8%

KLEINFELDER RECOMMENDS THE OWNER CONDUCT A
 POST-CONSTRUCTION ASSESSMENT OF THE ADA ELEMENTS
 FOR COMPLIANCE WITH THE 2010 ADA.




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0 50 100 150

SCALE: 1\* = 50' SCALE IN FEET

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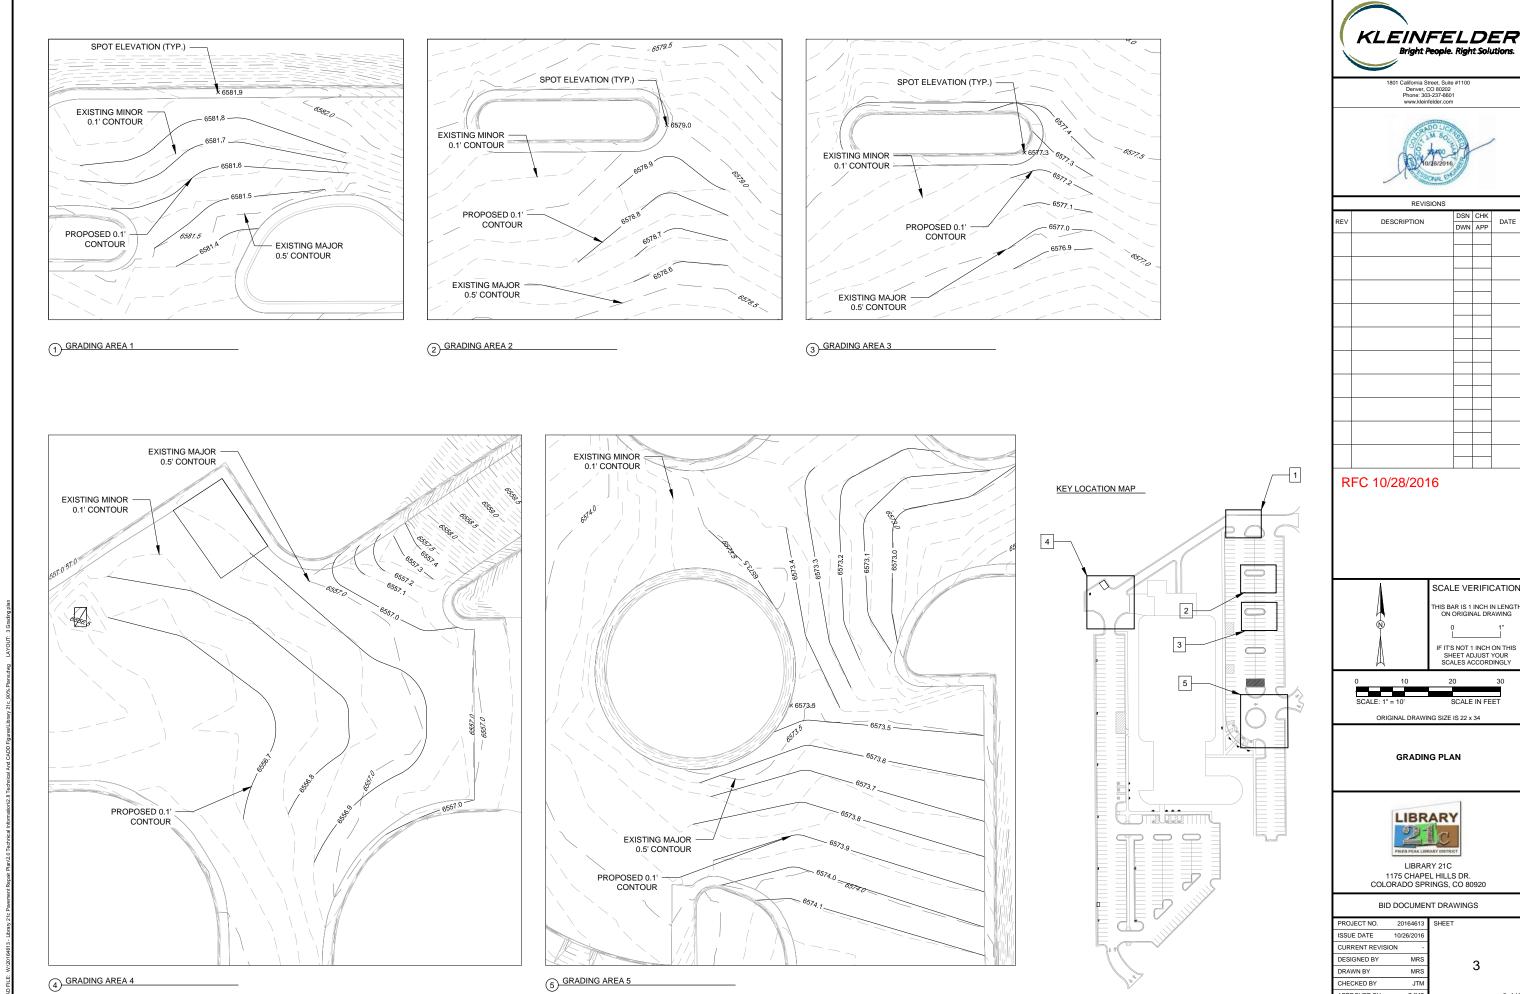
SITE REPAIR PLAN



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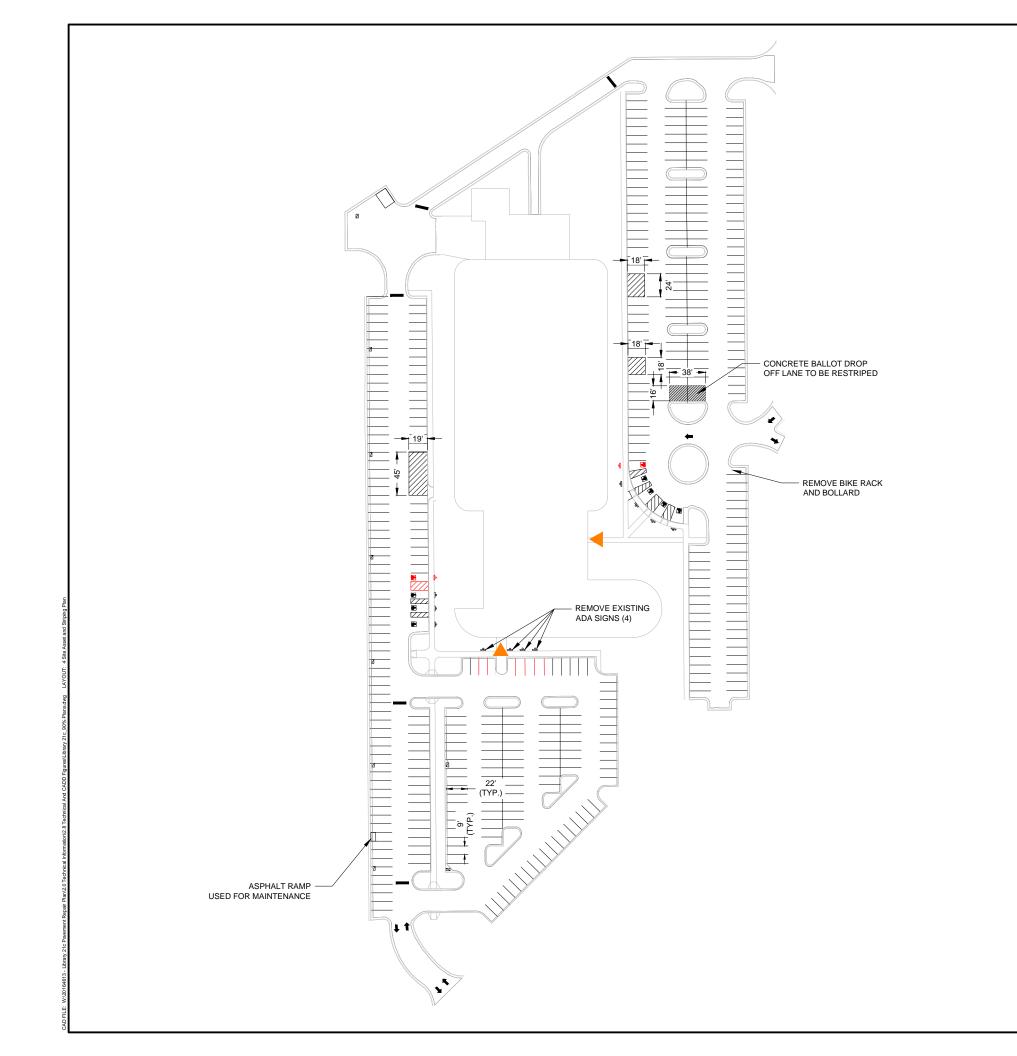
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CHECKED BY	JTM			
APPROVED BY	SJMS	I		3 of 1

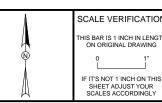

### SITE IMPROVEMENTS LEGEND

\_\_

INSTALL ADA SIGN AND POST (2)



NEW LAYOUT STRIPING

EXISTING/PROPSED STRIPING (SEE NOTES BELOW)



PUBLIC ENTRANCE / EXIT

INSTALL 16' LONG SPEED BUMP (5) SEE DETAIL 5 ON SHEET 9



ALL ITEMS THAT WERE ORIGINALLY PAINTED, STENCILED, OR STRIPED SHOULD BE REPAINTED, STENCILED, OR STRIPED WITH THE SAME COLOR AND DIMENSIONS PER TYPICAL STRIPING DETAILS 8 AND 9 ON SHEET 9.

PARKING STALL COUNT					
EXISTING PROPOSED					
VAN ACCESSIBLE STALLS	2	2			
TOTAL ADA STALLS	11	9			
TOTAL STALL COUNT	419	403			



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SCALE VERIFICATION

THIS BAR IS 1 INCH IN LENGTH ON ORIGINAL DRAWING 0 1"

IF IT'S NOT 1 INCH ON THIS SHEET ADJUST YOUR SCALES ACCORDINGLY

0 50 100 150

SCALE: 1\* = 50' SCALE IN FEET

ORIGINAL DRAWING SIZE IS 22 x 34

SITE ASSET AND STRIPING PLAN



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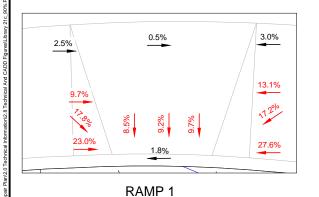
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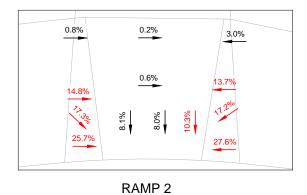
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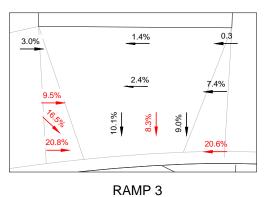
4 of 10

## 0.1% - ACCESS AISLE STRIPING (TYP.)

### AREA 3







### **EXISTING LEGEND**

X.X%


EXISTING CONDITIONS

X.X%

EXISTING NON-COMPLIANT SLOPE

EXISTING SLOPE

### KEY LOCATION MAP

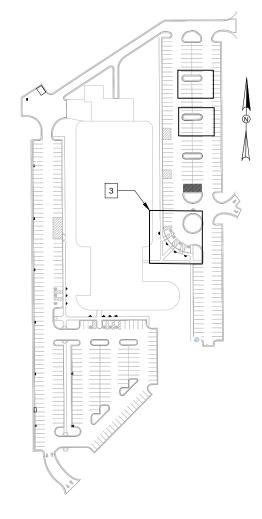

### NOTES:

- 1. CURB RAMPS WITH NON-COMPLIANT SLOPE SHALL BE REMOVED AND REPLACED ACCORDING TO CURB RAMP DETAIL 6 ON SHEET 9.
- 2. NON-COMPLIANT ADA PARKING STALLS AND ACCESS AISLES SHALL BE REGRADED TO MEET BUT NOT EXCEED THE FOLLOWING SLOPES:

ELEMENT	CROSS SLOPE	RUNNING SLOPE
CONCRETE ACCESSIBLE ROUTES	1.8%	4.8%
ASPHALT ACCESSIBLE ROUTES	1.5%	4.5%
CONCRETE ACCESSIBLE PARKING	1.8%	1.8%
ASPHALT ACCESSIBLE AREA	1.5%	1.5%
CONCRETE RAMPS	1.8%	7.8%
CONCRETE LANDINGS AND DOORWAYS	1.8%	1.8%





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SCALE VERIFICATION




ADA CHECK PLAN



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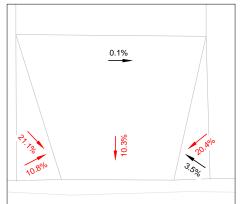


AREA 1


### NOTES:

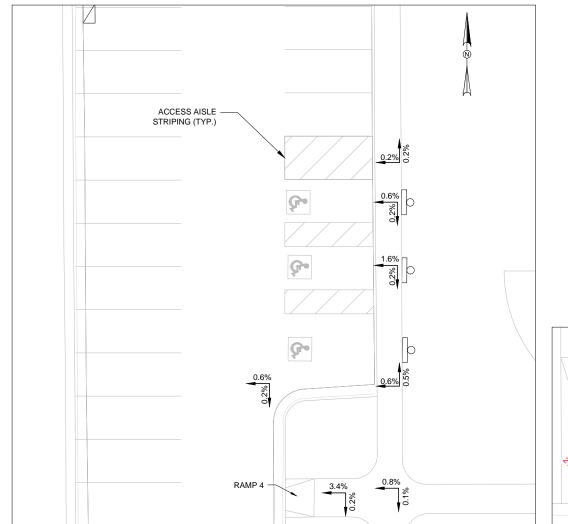- 1. CURB RAMPS WITH NON-COMPLIANT SLOPE SHALL BE REMOVED AND REPLACED ACCORDING TO CURB RAMP DETAIL ON SHEET 9.
- 2. NON-COMPLIANT ADA PARKING STALLS AND ACCESS AISLES SHALL BE REGRADED TO MEET ADA SPECIFICATIONS ON SHEET 2.
- 3. EXISTING ADA STALLS IN AREA 2 TO BE REMOVED. SEE AREAS 1 AND 3 FOR PROPOSED ADA AREAS.
- 2. NON-COMPLIANT ADA PARKING STALLS AND ACCESS AISLES SHALL BE REGRADED TO MEET BUT NOT EXCEED THE FOLLOWING SLOPES:

ELEMENT	CROSS SLOPE	RUNNING SLOPE
CONCRETE ACCESSIBLE ROUTES	1.8%	4.8%
ASPHALT ACCESSIBLE ROUTES	1.5%	4.5%
CONCRETE ACCESSIBLE PARKING	1.8%	1.8%
ASPHALT ACCESSIBLE AREA	1.5%	1.5%
CONCRETE RAMPS	1.8%	7.8%
CONCRETE LANDINGS AND DOORWAYS	1.8%	1.8%



RAMP 4

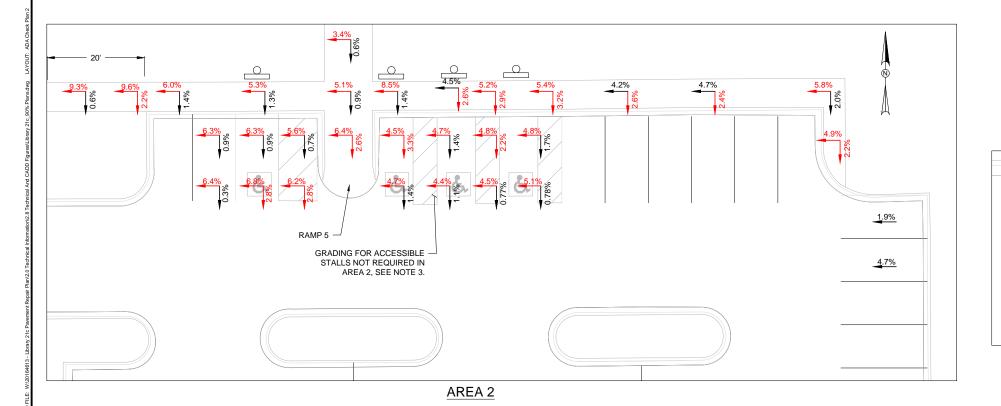


# RAMP 5

### **EXISTING LEGEND**

EXISTING CONDITIONS X.X% X.X%

NON-COMPLIANT SLOPE EXISTING SLOPE

KEY LOCATION MAP

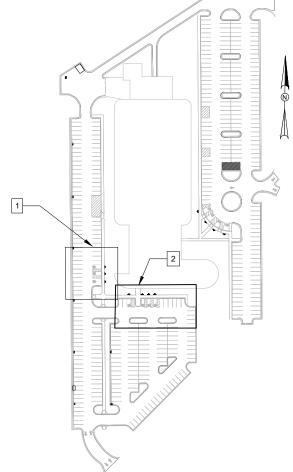





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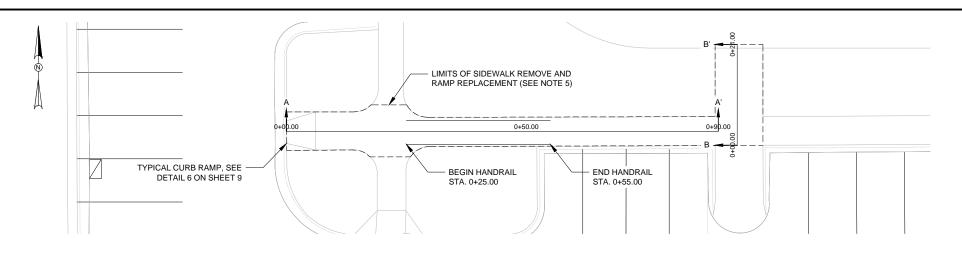
ADA CHECK PLAN



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APPROVED BY	SJMS	



### NOTES:

- SIDEWALK TO BE PCC APPROVED CITY MIX. SEE DETAIL 3, SHEET 9 FOR SIDEWALK THICKNESS
- SIDEWALK JOINTS PER DETAILS ON SHEET 10.
  EXISTING SIDEWALK TO BE SAWCUT AND JOINT PLACED AT TRANSITION TO NEW SIDEWALK PER DETAILS ON SHEET 10.
- MATCH EXISTING GRADE AT LIMITS OF SIDEWALK. SEE ADA
- NOTES ON SHEET 2 FOR ADA COMPLIANCE CRITERIA.
  SUBGRADE PREPARATION DETAILS ARE PRESENTED IN THE
  KLEINFELDER PAVEMENT EVALUATION REPORT PPLD LIBRARY 21C DATED AUGUST 10, 2016.

NOTE: DASHED LINE INDICATES

CONDITION WHERE BASEPLATE IS AT CORNER OF CONCRETE

EDGE OF

PLAN

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### SIDEWALK RAMP




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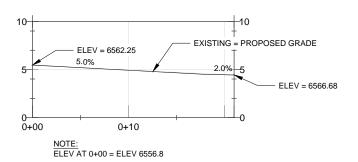
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DRAWN BY	JM		,
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APPROVED BY	SJMS		

### PLAN VIEW (SCALE 1" = 10')





NOTE: ELEV AT 0+00 = ELEV 6556.8

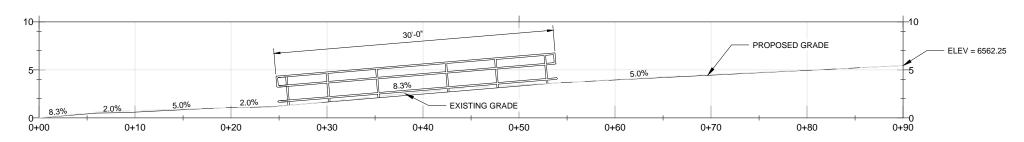
### PROFILE VIEW A-A' (SCALE 1" = 5')




### PROFILE VIEW B-B' (SCALE 1" = 5')

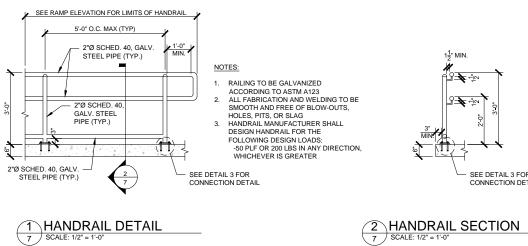

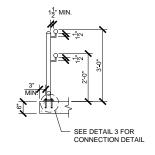


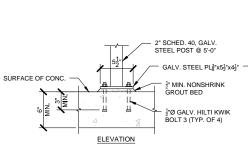


3 HANDRAIL CONNECTION DETAILS
7 SCALE: 1-1/2" = 1'-0"

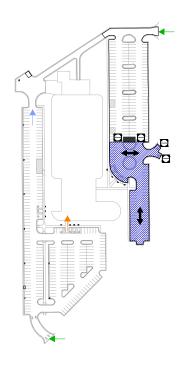


PHASE 1

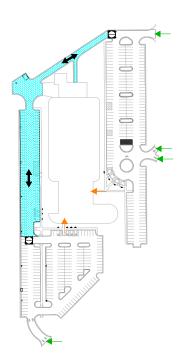


PHASE 3

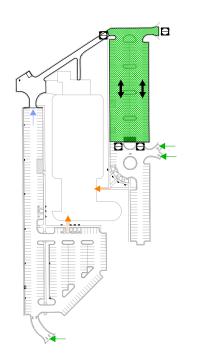

PHASE 2

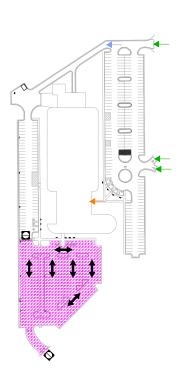

PHASING PLAN LEGEND

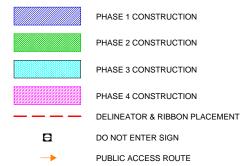

→ PUBLIC SITE ACCESS

DELIVERY ACCESS

→ PAVING DIRECTION

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0 1"

IF IT'S NOT 1 INCH ON THIS
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SCALES ACCORDINGLY

0 150 300 450

ORIGINAL DRAWING SIZE IS 22 x 34

PHASING PLAN




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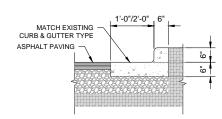
PHASE 4



- NOTES

  1. HIGH EARLY STRENGTH 4200 PSI MIX, SUCH AS CDOT CLASS E OR CITY OF COLORADO SPRINGS APPROVED EQUIVALENT. MINIMUM 3-DAY STRENGTH OF 2,500 PSI.
- BASE COURSE TO CONFORM TO CDOT STANDARDS FOR BASE COURSE COMPACTED TO 95% OF THE MODIFIED PROCTOR (ASTM D-1557) MAXIMUM DRY DENSITY.
- THE PAVEMENT REHABILITATION DETAILS ARE PRÉSENTED IN THE KLEINFELDER PAVEMENT EVALUATION REPORT PPLD LIBRARY 21C DATED AUGUST 10, 2016.
- ALL SUBGRADE AND PAVEMENT OPERATIONS AND MATERIALS THAT ARE NOT INCLUDED IN THE ABOVE REFERENCE SHALL MEET THE MINIMUM REQUIREMENTS CDOT STANDARDS AND SPECIFICATION MANUAL
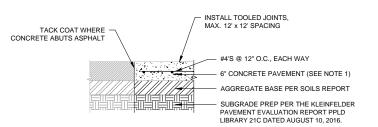
### LOADING DOCK CONCRETE PAVEMENT N.T.S




- SLOPE ON GUTTER PLATE SHOULD BE \$\frac{1}{2}\text{ PER FOOT MIN. SLOPE AND SHALL PERMIT POSITIVE DRAINAGE TO DRAINAGE STRUCTURES. SLOPE TOWARDS OR AWAY FROM CURB AS REQUIRED.

  EXPANSION JOINT: PLACED AT ENDS OF ALL RADII, 5' ON EACH SIDE OF DRAINAGE STRUCTURES, AND 45'
- MAX. SPACING IN STRAIGHT CURB AND GUTTER. PROVIDE #6x18" LONG SMOOTH STEEL DOWEL BARS WITH 1" DIA. GREASE CAP THROUGH EXPANSION JOINTS.  $\binom{2^n}{4}$  BITUMINOUS FILLER MATERIAL).
- CONTRACTION JOINT: PROVIDE 2" DEEP x  $^1_4$ " WIDE CONTRACTION JOINTS AT 15' INTERVALS. 2-6' LONG TIE BAR ON 2-6' CENTERS SHALL BE PROVIDED WHEN CURB IS ADJACENT TO PCC PAVEMENT. PROVIDE 2-#6  $\times$  2'-6" LONG TIE BARS TO CONNECT EXISTING AND NEW CURB AND GUTTER. REMOVE
- FORMS AS EARLY AS POSSIBLE. BRUSH TOP AND FACE OF CURBS TO REMOVE ALL IMPERFECTIONS.
- ALL RADII SHALL BE TRUE ARCS.
- LIGHT BROOM FINISH ON ALL EXTERIOR CONCRETE

N.T.S



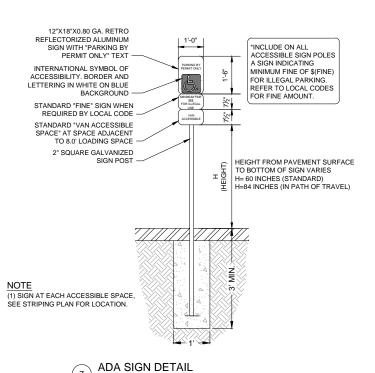


ASPHALT PAVEMENT (SEE NOTE 1) .... AGGREGATE BASE PER SOILS REPORT SUBGRADE PREP PER THE KLEINFELDER PAVEMENT EVALUATION REPORT PPLD IBRARY 21C DATED AUGUST 10, 2016

### **NOTES**


- CONTRACTOR SHALL SUBMIT MIX DESIGN TO THE ENGINEER FOR APPROVAL SEVEN
  (7) DAYS PRIOR TO THE BEGINNING OF PAVEMENT OPERATION. THE MIX DESIGN SHALL BE DEVELOPED USING THE CDOT SUPERPAVE MIX DESIGN PROCEDURES PER SECTION 403.03 OF THE "STANDARD SPECIFICATION FOR ROAD AND BRIDGE CONSTRUCTION". SUBGRADE COMPACTION PER SOILS REPORT.
- BASE COURSE TO CONFORM TO COOT STANDARDS FOR BASE COURSE COMPACTED TO 95% OF THE MODIFIED PROCTOR (ASTM D-1557) MAXIMUM DRY DENSITY
- PROVIDE TACK COAT BETWEEN BASE COURSE AND SURFACE COURSE.

### PARKING LOT ASPHALT PAVEMENT N.T.S

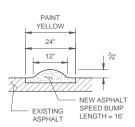


SPEED BUMP DETAIL N.T.S




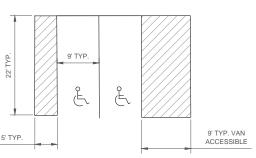

TYPICAL ADA STALL N.T.S

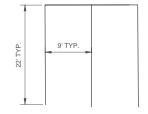

TYPICAL STALL N.T.S

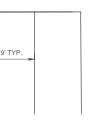

### INTERNATIONAL SYMBOL OF ACCESSIBILITY NOTES

5'-0"

- SYMBOL TO BE CENTERED ON WIDTH OF PARKING STALL. BOTTOM OF SYMBOL TO BE LOCATED 2'-6" FROM ACCESS DRIVE, INTO PARKING SPACE.
- SYMBOL IS REQUIRED TO CONTRAST WITH BACKGROUND

ADA SYMBOL N.T.S



INSTALL TOOLED JOINTS AT SPACING EQUAL TO THE

DETECTABLE WARNING

PAINT TOP AND FACE OF

CURB WITHIN SIDE FLARE LIMIT YELLOW (TYP.)

WHITE OR YELLOW PAINT FIGURE CONTRASTING BLUE BACKGROUND

PAINT. NO BACKGROUND PAINT REQUIRED IF WHITE OR YELLOW FIGURE IS ON BLACK ASPHALT

6" MIN

EXISTING SIDEWALK

WALK WIDTH

MATCH EXISTING

#4 BARS @16" O.C. EACH WAY

SUBGRADE PREP PER THE KLEINFELDER PAVEMENT EVALUATION REPORT PPLD LIBRARY 21C DATED AUGUST 10, 2016.

SAWCUT, REMOVE AND REPLACE 2' x TOTAL WIDTH OF RAMP. PROVIDE REPLACEMENT ASPHALT TO MATCH EXISTING THICKNESS IN

<u>NOTES</u>

TWO LIFT COURSES

PROVIDE COARSE BROOM FINISH IN A

MAX. LONGITUDINAL SLOPE IS 8%.

N.T.S

TRAVERSE DIRECTION TO SLOPE OF RAMP (IF REQUIRED TO MATCH EXISTING).

MAXIMUM LANDING SLOPE IN ANY DIRECTION IS

CONCRETE CURB RAMP

2% MINIMUM LANDING DIMENSIONS 5'x5'.
MAXIMUM CROSS SLOPE ON RAMP IS 2% AND

**NEW SIDEWALK** 



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SCALE VERIFICATION

HIS BAR IS 1 INCH IN LENGT IF IT'S NOT 1 INCH ON THIS SHEET ADJUST YOUR SCALES ACCORDINGLY

ORIGINAL DRAWING SIZE IS 22 x 34


DETAILS



LIBRARY 21C 1175 CHAPEL HILLS DR. COLORADO SPRINGS, CO 80920

BID DOCUMENT DRAWINGS

PROJECT NO.	20164613	SHEET
ISSUE DATE	10/26/2016	
CURRENT REVISION	ON -	
DESIGNED BY	MRS	
DRAWN BY	JM	
CHECKED BY	JTM	
1 DDD 61/ED D1/	0 11.10	

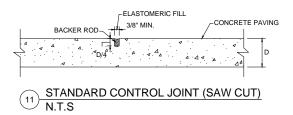

NEW CONCRETE SECTION-

COMPACTED SUBGRADE PER SOIL RECOMMENDATIONS

CUT 1/2" DEEP TRENCH ALONG SEAM AND


EXISTING CONCRETE TO REMAIN SAWOUT FULLY THROUGH CONCRETE SECTION AS NEEDED TO PROVIDE SMOOTH CLEAN SURFACE

JOINT SEAL


NOTE: SMOOTH CLE
NEW SECTION MAY BUTT UP TO EXISTING
CONCRETE UNLESS EXPANSION JOINT IS
SPECIFICALLY CALLED OUT

STANDARD SAWCUT JOINT FOR NEW CONCRETE DETAIL

N.T.S

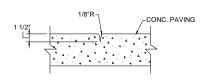



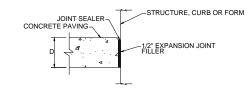

STANDARD ISOLATION JOINT N.T.S





	REVISIONS			
REV	DESCRIPTION	DSN DW N	CHK APP	DATE

RFC 10/28/2016

SCALE VERIFICATION THIS BAR IS 1 INCH IN LENGTH ON ORIGINAL DRAWING

IF IT'S NOT 1 INCH ON THIS SHEET ADJUST YOUR SCALES ACCORDINGLY

ORIGINAL DRAWING SIZE IS 22 x 34

DETAILS



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